


PERSPECTIVE



NORTH ELEVATION

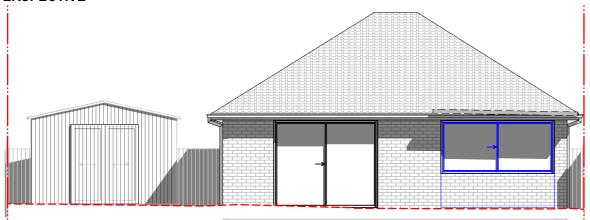



EAST ELEVATION

NOTES


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CLIENT



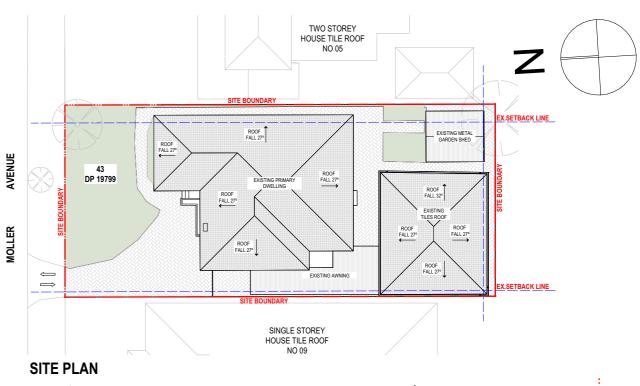

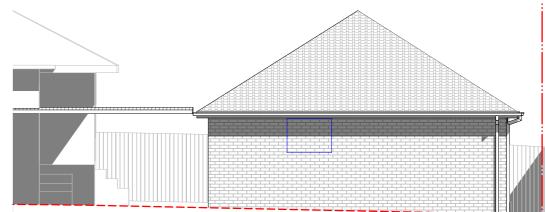WEST ELEVATION

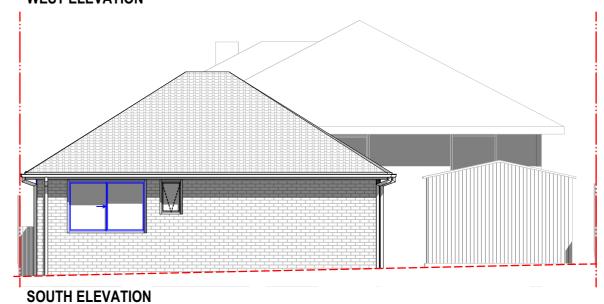

PROPOSED FREE-STANDING GRANNY FLAT 7 MOLLER AVENUE, BIRRONG, NSW 2143

Drawing Title

GENERAL Notification Plan Scale 1:300, <u>1:100</u> @ A3 Status

Project No. 24053 Dwg No.





59 The River Road Revesby, NSW 2212 AUSTRALIA

DA-000

PROJECT: PROPOSED FREE-STANDING GRANNY FLAT **ADDRESS:** 7 MOLLER AVENUE, BIRRONG, NSW 2143

LOT #: 43 DP 19799

SECTION #:



DRAWING LIST

DRAWING LIS	I		
DRAWING.No	DRAWING NAME	REVISION	DATE
DA-000	Notification Plan	Α	22.02.25
DA-001	Cover Page	Α	22.02.25
DA-002	Basix	Α	22.02.25
DA-004	Site Management and Demolition Plan	Α	22.02.25
DA-005	Site Analysis	Α	22.02.25
DA-006	Site Plan	Α	22.02.25
DA-007	Ground Level	Α	22.02.25
DA-008	Elevations	Α	22.02.25
DA-009	GFA Calculation	Α	22.02.25
DA-010	Ground Level	Α	22.02.25
DA-011	Elevations	Α	22.02.25
DA-012	Sections	Α	22.02.25
DA-013	Window Schedule	Α	22.02.25
DA-014	Shadow Diagrams	Α	22.02.25
DA-015	Material Board	Α	22.02.25
DA-016	Perspective 01	Α	22.02.25

7 MOLLER AVENUE, BIRRONG, NSW 2143

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CLIENT

PROPOSED FREE-STANDING GRANNY FLAT 7 MOLLER AVENUE, BIRRONG, NSW 2143

Drawing Title

GENERAL Cover Page

Scale	Project No.		Drawn by	North
1:1 @ A3	•	24053	ĹL	
Status	Dwg No.		Rev	
For Information		DA-001		



59 The River Road Revesby, NSW 2212 AUSTRALIA



Single Dwelling

Certificate number: 1785541S

This certificate confirms that the proposed development will meet the NSW government's requirements for sustainability, if it is built in accordance with commitments set out below. Terms used in this certificate, or in the commitments have the meaning given by the document entitled 'BASIX Definitions' dated 10/09/2020 published by the Department. This document is available at www.basix.nsw.gov.au

Secretary
Date of issue: Friday, 28 February 2025
To be valid, this certificate must be submitted with a development application or lodged with a complying development certificate application within 3 months of the date of issue.



Project summary							
Project name	n.SA008_Birrong 7	n.SA008_Birrong 7 Moller ave					
Street address	7 MOLLER Avenue	BIRRONG 2143					
Local Government Area	Canterbury-Banksti	own Council					
Plan type and plan number	Deposited Plan DP	19799					
Lot no.	43						
Section no.	-						
Project type	dwelling house (det	ached) - secondary dwelling					
No. of bedrooms	2						
Project score							
Water	✓ 40	Target 40					
Thermal Performance	✓ Pass	Target Pass					
Energy	✓ 71	Target 68					
Materials	✓ 2	Target n/a					

Certificate Prepared by	
Name / Company Name: BIANCA VU NGUYEN	
ABN (if applicable):	

Name / Company Name: BIANCA VU NGUYEN
ABN (if applicable):

mulation Method	DA plans	plans & specs	check
sessor details and thermal loads			
applicant must attach the certificate referred to under "Assessor Details" on the front page of this BASIX certificate (the "Assessor partificate") to the development application and construction certificate application for the proposed development (or, if the applicant is plying for a complying development certificate for the proposed development, to that application). The applicant must also attach the sessor Certificate to the application for an occupation certificate for the proposed development.			
e Assessor Certificate must have been issued by an Accredited Assessor in accordance with the Thermal Comfort Protocol.			
e details of the proposed development on the Assessor Certificate must be consistent with the details shown in this BASIX rificate, including the Cooling and Heating loads shown on the front page of this certificate and the "Construction" and "Glazing" loes below.			
e applicant must show on the plans accompanying the development application for the proposed development, all matters which Associated requires to be shown on those plans. Those plans must bear a stamp of endorsement from the Accredited sessors to certify that this is the case. The applicant must show on the plans accompanying the application for a construction rifficate (or complying development certificate, it, applicable), all thermal performance specifications set out in the Assessor trifficate, and all aspects of the proposed development which were used to calculate those specifications.	•	~	~
e applicant must construct the development in accordance with all thermal performance specifications set out in the Assessor rifficate, and in accordance with those aspects of the development application or application for a complying development certificate ich were used to calculate those specifications.		~	~
e applicant must show on the plans accompanying the development application for the proposed development, the locations of illing fans set out in the Assessor Certificate. The applicant must show on the plans accompanying the application for construction rificate (or complying development certificate, it applicable), the locations of ceiling fans set out in the Assessor Certificate	~	~	~

Energy Commitments	Show on DA plans	Show on CC/CDC plans & specs	Certifie check
Hot water			
The applicant must install the following hot water system in the development, or a system with a higher energy rating: gas instantaneous with a performance of 6 stars.	~	~	•
Cooling system			
The applicant must install the following cooling system, or a system with a higher energy rating, in at least 1 living area: 1-phase airconditioning - non ducted; Energy rating: 5 star (average zone)		~	•
The applicant must install the following cooling system, or a system with a higher energy rating, in at least 1 bedroom: 1-phase airconditioning - non ducted; Energy rating: 5 star (average zone)		~	•
Heating system			
The applicant must install the following heating system, or a system with a higher energy rating, in at least 1 living area: 1-phase airconditioning - non ducted; Energy rating: 5 star (average zone)		~	•
The applicant must install the following heating system, or a system with a higher energy rating, in at least 1 bedroom: 1-phase airconditioning - non ducted; Energy rating: 5 star (average zone)		~	-
Ventilation			
The applicant must install the following exhaust systems in the development:			
At least 1 Bathroom: individual fan, ducted to façade or roof; Operation control: manual switch on/off		-	•
Kitchen: individual fan, ducted to façade or roof; Operation control: manual switch on/off		~	-
Laundry: natural ventilation only, or no laundry; Operation control: n/a		•	•
Artificial lighting			
The applicant must ensure that a minimum of 80% of light fixtures are fitted with fluorescent, compact fluorescent, or light-emitting- diode (LED) lamps.		~	-
Natural lighting			
The applicant must install a window and/or skylight in 1 bathroom(s)/toilet(s) in the development for natural lighting.			

	Show o			Certifier check
03_01_0 Certificate No.: 1785541S	S	Friday, 28 Febru	ary 2025	page 1
N (if applicable):				
ne / Company Name: BIANCA VU No	GUYEN	4		
rtificate Prepared by				
		,		
erials	~	2		Target n/a
rgy	~	71		Target 68
rmal Performance	v	Pass		Target Pass
er	~	40		Target 40

	nts		w on plans	Show on CC/CDC plans & specs	Certifi check
Construction					
The applicant must construct the floors, walls, roofs, ceilings a the tables below.	and glazing of the dwelling in accordance with the specifications	listed in	•	_	-
The applicant must show through receipts that the materials p the tables below.	urchased for construction are consistent with the specifications	listed in			-
Construction	Area - m²	Insulation			
floor - concrete slab on ground, conventional slab.	57.5	not specified			
external wall: brick veneer; frame: timber - H2 treated softwood.	all external walls	rockwool batts, r	roll or pu	ump-in+ foil/sarking	
internal wall: plasterboard; frame: timber - untreated softwood.	35.9	none			
ceiling and roof - flat ceiling / pitched roof, framed - concrete tiles , timber - H2 treated softwood.	61.4	ceiling: fibreglass batts or roll; roof: foil backed bla			blanket.

Description of project

Local Government Area
Plan type and plan number
Lot no.

Project type

Roof area (m²)

Roof area of the existing dwelling (m²) 167

n.SA008_Birrong 7 Moller ave 7 MOLLER Avenue BIRRONG 2143

Canterbury-Bankstown Cou Deposited Plan DP19799

DMN/24/2220 HR-BWFM2F-02

Pass

71

✓ 2

Target 40

Target Pass

Target 68

NatHERS certificate number

				DA pi	ins plans & specs	CHECK
Oth	er					
The	applicant must install a gas cooktop & ele	ectric oven in the kitchen of	the dwelling.			
ISIX	December of Discourse Hearts		Version Ann (FUNAL VERSION CT. T. T.	Continue No. 47077717	Friday On Fabruary Total	
DIA	Department of Planning, Housing and Infrastructure	www.basiX.nsw.gov.au	Version: 4.03 / EUCALYPTUS_03_01_0	Certificate No.: 1785541S	Friday, 28 February 2025	

Water Commitments	Show on DA plans	Show on CC/CDC plans & specs	Certifier check
Fixtures			
The applicant must install showerheads with a minimum rating of 4 star (> 4.5 but <= 6 L/min plus spray force and/or coverage tests) in all showers in the development.		~	~
The applicant must install a toilet flushing system with a minimum rating of 5 star in each toilet in the development.		~	~
The applicant must install taps with a minimum rating of 5 star in the kitchen in the development.		~	
The applicant must install basin taps with a minimum rating of 5 star in each bathroom in the development.		~	
Alternative water			
Rainwater tank			
The applicant must install a rainwater tank of at least 1500 litres on the site. This rainwater tank must meet, and be installed in accordance with, the requirements of all applicable regulatory authorities.	~	~	~
The applicant must configure the rainwater tank to collect rain runoff from at least 160 square metres of the roof area of the development (excluding the area of the roof which drains to any stormwater tank or private dam).		~	~
The applicant must connect the rainwater tank to:			
all toilets in the development		-	-
 at least one outdoor tap in the development (Note: NSW Health does not recommend that rainwater be used for human consumption in areas with potable water supply.) 		•	-
consumption in areas with potable water supply.)	I	. •	•

Thermal Performance and Materials con	nmitments		Show on DA plans	Show on CC/CDC plans & specs	Certifier check
Glazing					
The applicant must install windows, glazed doors an listed in the table.	d skylights as described in the tab	le below, in accordance with the specifications	~	~	~
Frames		Maximum area - m2			
aluminium		20.3			
timber		0			
uPVC		0			
steel		0			
composite		0			
Glazing		Maximum area - m2			
single		20.3			
double		0			
triple		0			

Lege	end					
In the	se commitments, "applicant" means the p	person carrying out the de	velopment.			
Commitments identified with a V in the "Show on DA plans" column must be shown on the plans accompanying the development application for the proposed development (if a development application is to be lodged for the proposed development).						
Comr	nitments identified with a V in the "Show icate / complying development certificate	on CC/CDC plans and sp for the proposed develop	pecs" column must be shown in the plans ment.	and specifications accompany	ing the application for a construct	ion
	nitments identified with a in the "Certif for the development may be issued.	ier check" column must b	e certified by a certifying authority as havi	ing been fulfilled, before a final	occupation certificate (either inter	im or

Scale

Status

@ A3

NOTES

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CLIENT

PROPOSED FREE-STANDING GRANNY FLAT 7 MOLLER AVENUE, BIRRONG, NSW 2143

Drawing Title

GENERAL Basix

Project No. Dwg No.


24053

Drawn by



59 The River Road Revesby, NSW 2212 AUSTRALIA

DA-002

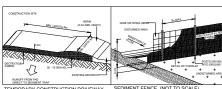



INFUSSIBLE FOR TRUCKS TO BE DIRECTED OUT AT ALL TIMES BY W MANNER, TRUCKS TO BE DIRECTED OUT AT ALL TIMES BY W POSSIBLE BY SITE SUPERVISOR VEHICLES TO ENTER THE SITE ONTO AREA OF ROAD BASE AS INDICATED WASHED OFF AS NECESSARY AND LEAVE THE SITE IN A SAFE MANNER

OVISIONS FOR PUBLIC SAFETY

UST CONTROL MEASURES WATERING OF DUST FROM EXCAVATION

NOT APPLICABLE
PROVIDED TO FRONT OF SITE

SEDIMENT CONTROL INSTALLATION SEQUENCE

1. ESTABLISH A SINGLE STABILISE ENTRYEXIT POINT (RUMBLE PAD).

2. INSTALL SEDIMENT FENCE(S), ALONG THE LOW SIDE OF THE SITE.

3. DIVERT UP-SLOPE WATER AROUND THE WORK SITE AND APPROPRIATELY STABILISE

J. JUNENT UP-SLUPE WATER AROUND THE WORK SITE AND APPROPRIATELY STABILISE ANY DRAINAGE CHANNELS.

4. CLEAR ONLY THE AREAS NECESSARY (MAINTAINING VEGETATION ON PATHS).

5. STOCKPIE TOPOSIL WITHIN THE SEDIMENT CONTROLLED ZONE.

6. STABILISE EXPOSED EARTH BANKS (FOR EXAMPLE, WITH VEGETATION OR EROSION CONTROL BLANKETS).

7. INSTALL ON-SITE WASTE RECEPTACLES (MINI-SKIPS, BINS, WIND-PROOF LITTER RECEPTORS).

RECEPTORS). 8. INSTALL ROOF DOWNPIPES AS SOON AS PRACTICABLE AFTER THE ROOF IS LAID. 9. ENSURE THAT ALL CONTROL MEASURES ARE MAINTAINED IN GOOD WORKING

ORDER. 10. REVEGETATE OR OTHERWISE STABILISE THE SITE.

STABILISED ENTRY / EXIT POINT

"MANAGE ENTRY/EXIT POINT (RUMBLE PAD) SO THAT SEDIMENT IS NOT TRACKED OFF

NOTE: THE LOCATION OF THE PERMANENT DRIVEWAY MAY NOT BE AN APPROPRIATE LOCATION FOR THE CONSTRUCTION ENTRANCE.

SEDIMENT BARRIERS AND FENCES

"INSTALL GEOTEXTILE SEDIMENT BARRIERS AND FENCES ALONG THE LOWER SIDE OF THE SOLL DISTURBANCE, (WINETED TO STEEL POSTS).

THE SURPORT POSTS ARE SPACED NO GREATER THAN 2 METRES APART AND THE SEDIMENT FENCE BURIED TO A DEFINE OF 250 METERS APART AND THE SEDIMENT BARRIERS NOT BE LOCATED OUTSIDE PROPERTY BOUNDARIES WITHOUT COUNCIL APPROVED THE SEDIMENT SEARCH SOLL OF THE SEDIMENT SEARCH SEDIMENT SEARCH SOLL OF THE SEDIMENT SEDIMENT LADEN WATER.

EROSION CONTROLS

ENTITION OF THE CLEAR TO A MINIMUM, AND SHOULD ONLY BE COMMENCED MINEDATELY PRIOR TO BUILDING.

"BASILY PRIOR TO BUILDING."

"MAINTAIN AS MICH SOIL COVERAGE AS POSSIBLE WITH THE USE OF GRASS, LEAF MAINTAIN AS MICH SOIL COVERAGE AS POSSIBLE WITH THE USE OF GRASS, LEAF LANKET (EQ. OF MATTING."


"AGREEMENT OF THE CONTROLL OF THE WORK SITE ASSISTS IN FLITERING OUT SEDIMENT WHERE PRACTICABLE MAINTAIN KERB VEGETATION IN A HEALTHY STATE DURING THE BUILDING PROCESS.


DURING THE BUILDING HOUCESS.
STOCKPILES
'STOCKPILES
'STOCKPILES
'STOCKPILES
'STOCKPILES
ON BUILDING MATERIALS SHOULD NOT BE STORED ON THE FOOTPATH
OR WITHIN THE ROAD RESERVE, UNLESS PERMISSION OBTAINED FROM LOCAL
COUNCIL
'MINIMISE STOCKPILE LOSSES WITH THE USE OF COVERS. ALL STOCKPILES AND
BUILDING MATERIALS SHOULD BE LOCATED WITHIN THE SEDIMENT CONTROL ZONE,
FOR EXAMPLE GENIND A SEDIMENT FENCE.
'STOCKPILES NOT TO BE LOCATED WITHIN AN OVERTABLE FLOW PATH.

MAINTENANCE OF CONTROL MEASURES
ALL EROSION, SEDIMENT AND DRAINAGE CONTROL MEASURES NEED TO BE
REGULARLY CHECKED AND MAINTAINED IN GOOD WORKING ORDER. SEET PRACTICE
INCLUDES ANTICIPATION OF POTENTIAL RISKS AND BEING PREPARED FOR ABNORMA

INCLIDES ANTICIPATION OF POTENTIAL RISKS AND BEING PREPARED FOR ABNORMAL CIRCUMSTRACES AND EMERGENCIES.
THESE MEASURES INCLUDE:
"STOCKPILE EXTRA SEDIMENT FENCE FABRIC AND POSTS ONSITE TO FACILITATE EMERGENCY REPAIRS.
TOTO THE ENTRY SEDIMENT FOR THE SEDIMENT IS REMOVED AT REGULAR INTERVALS FROM SEDIMENT BARRIERS.

CHICK DAILY AND REPLACE BARRIERS DAILY IF THEY ARE RIPPED, DAMAGED OR NO

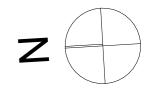

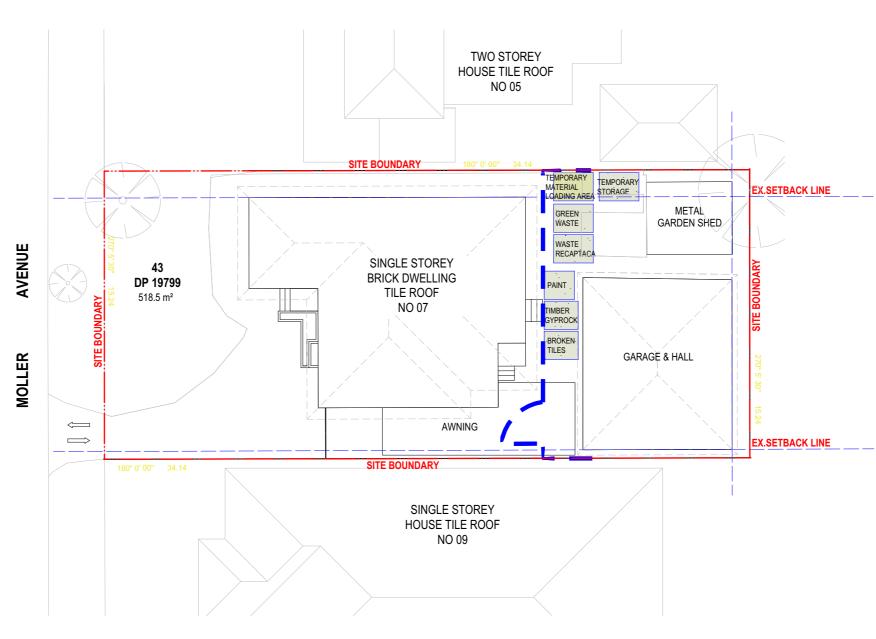


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PROPOSED FREE-STANDING GRANNY FLAT 7 MOLLER AVENUE, BIRRONG, NSW 2143

Drawing Title


Siteworks

Site Management and Demolition Plan



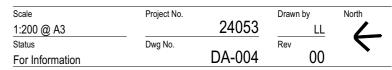

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CLIENT

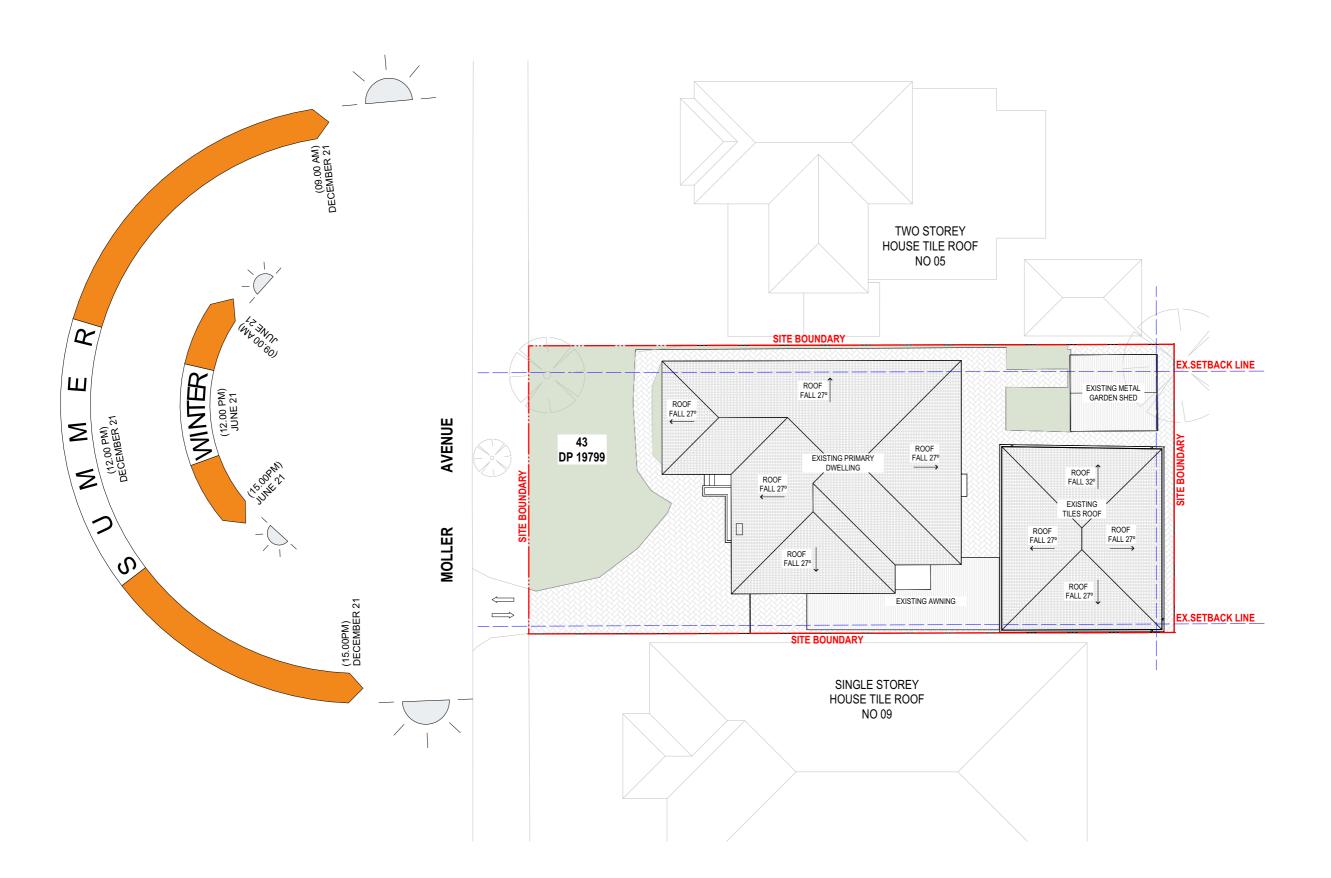Project Title

PROPOSED FREE-STANDING GRANNY FLAT 7 MOLLER AVENUE, BIRRONG, NSW 2143


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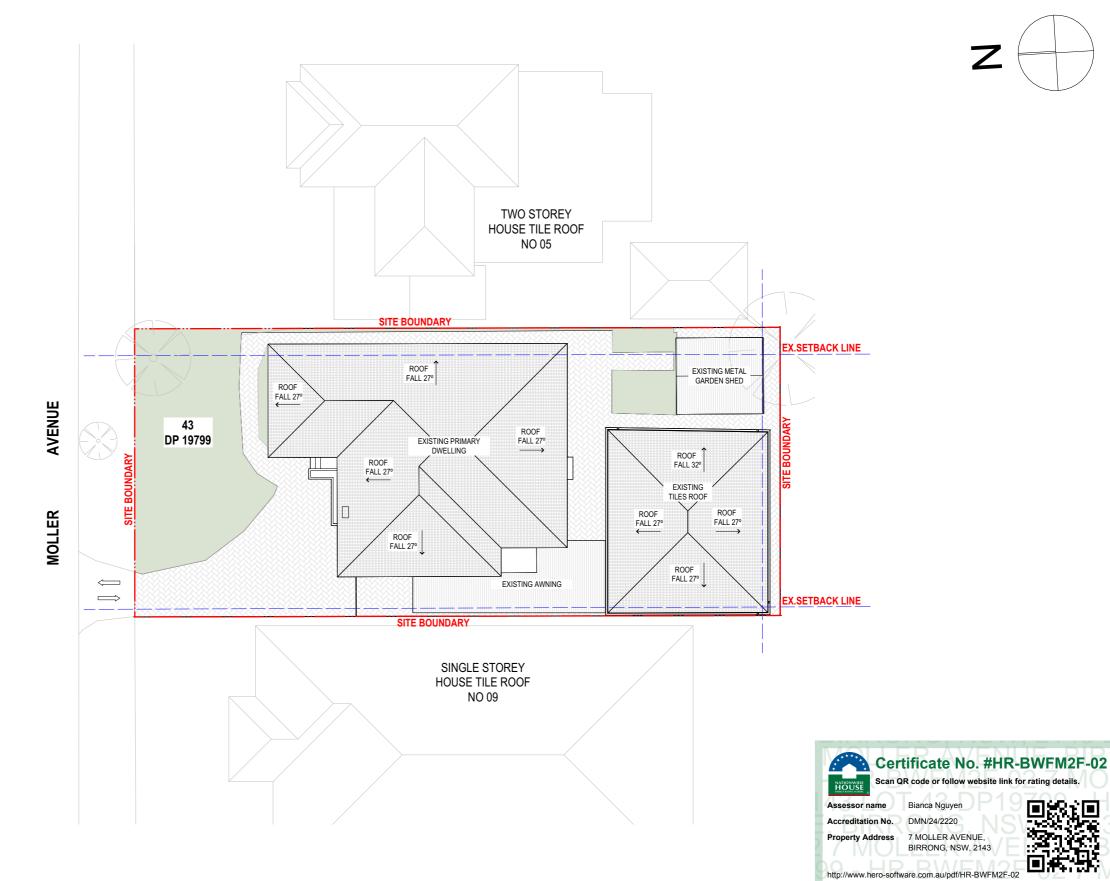
Siteworks Site Analysis

Scale	Project No.		Drawn by	North
1:200 @ A3	•	24053	· LL	
Status	Dwg No.		Rev	
For Information		DA-005		•



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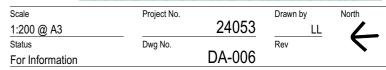
CLIENT

PROPOSED FREE-STANDING GRANNY FLAT 7 MOLLER AVENUE, BIRRONG, NSW 2143

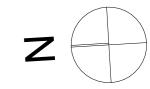Drawing Title


Siteworks Site Plan










59 The River Road Revesby, NSW 2212 AUSTRALIA

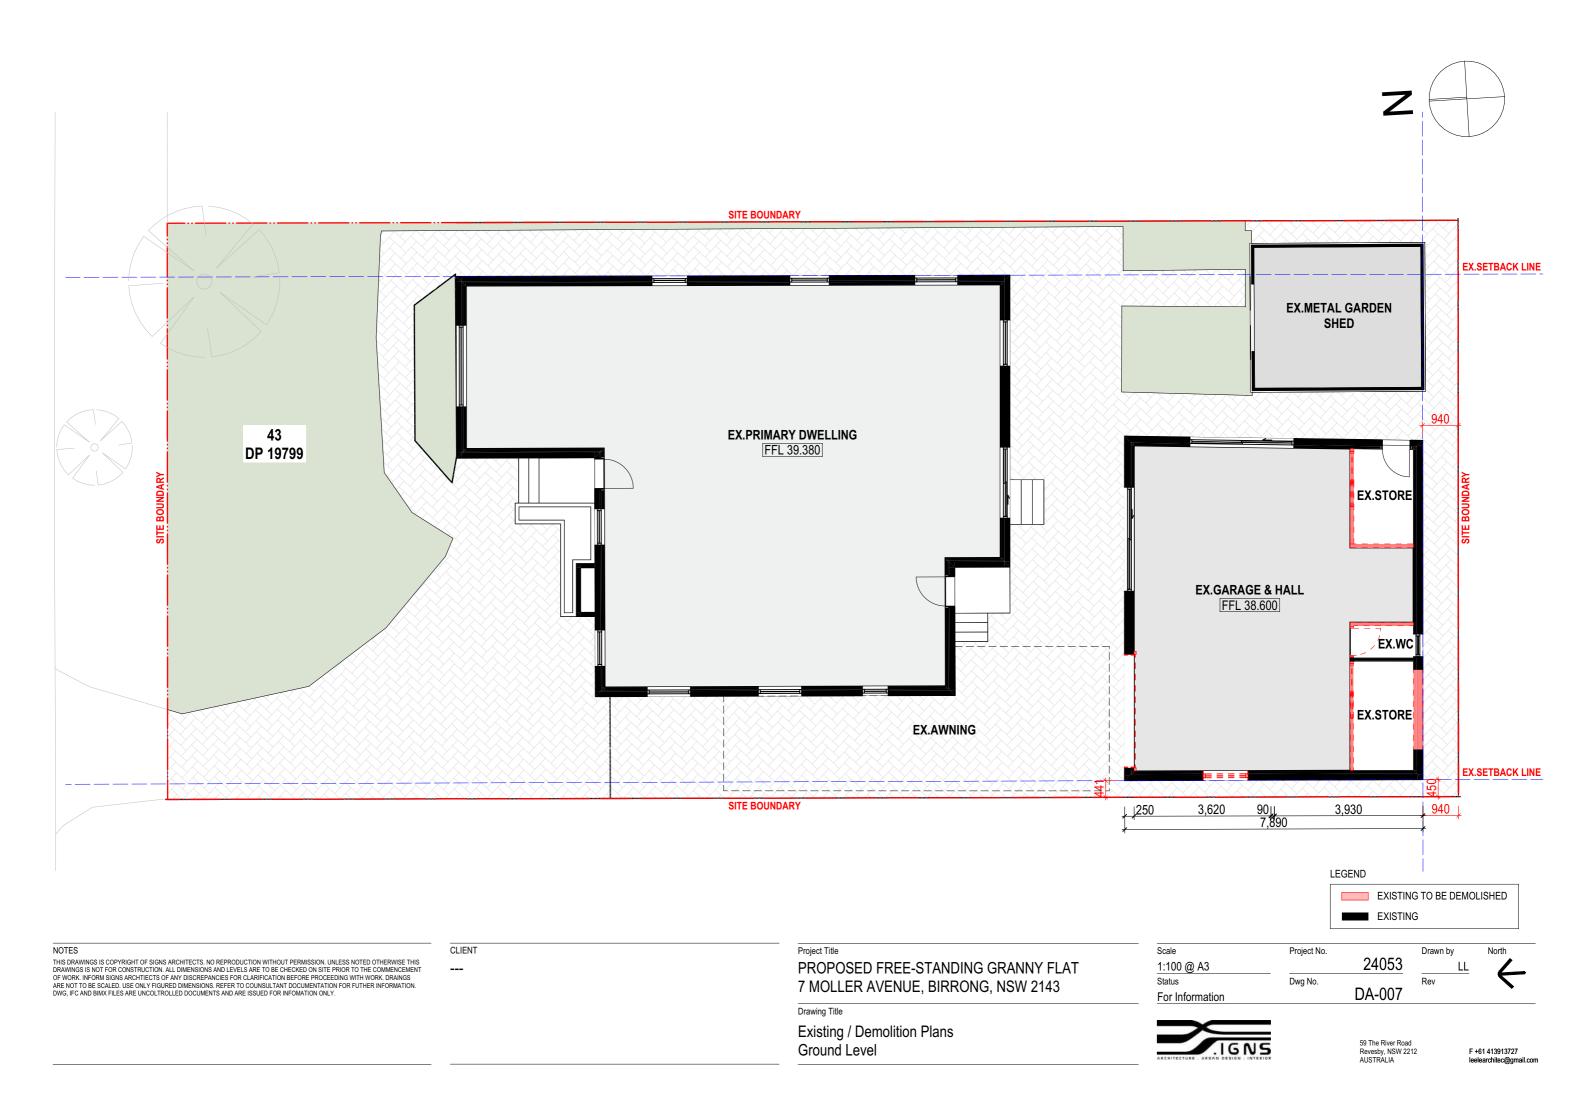


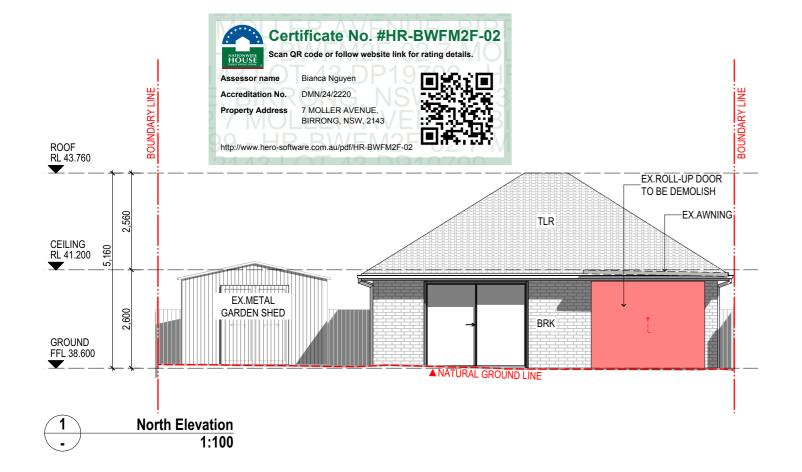

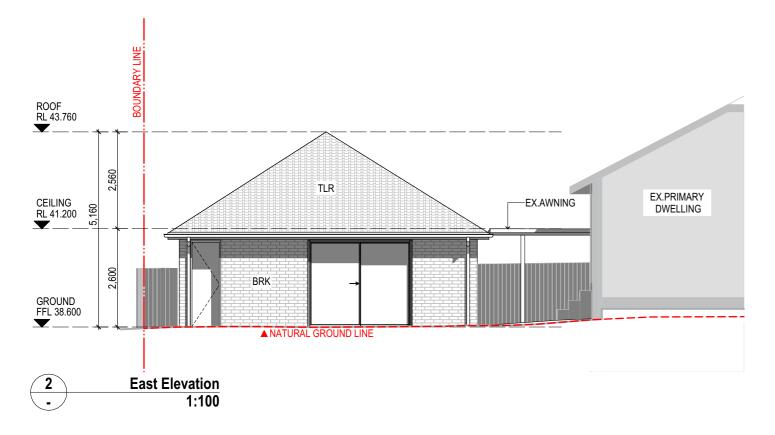

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PROPOSED FREE-STANDING GRANNY FLAT 7 MOLLER AVENUE, BIRRONG, NSW 2143

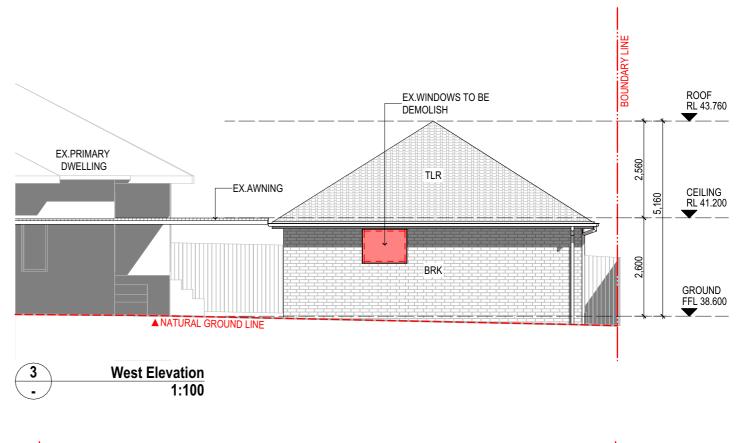Drawing Title

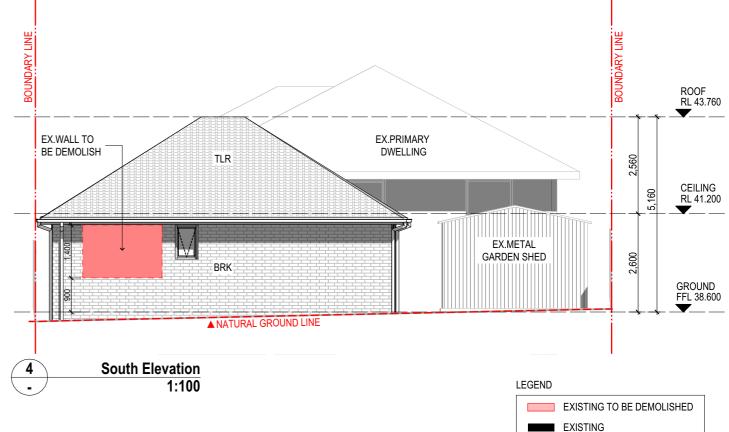Existing / Demolition Elevations Elevations


 Scale
 Project No.
 Drawn by
 North


 1:100 @ A3
 24053
 LL
 Rev

 For Information
 DA-008



59 The River Road Revesby, NSW 2212 AUSTRALIA

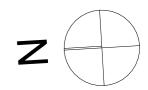

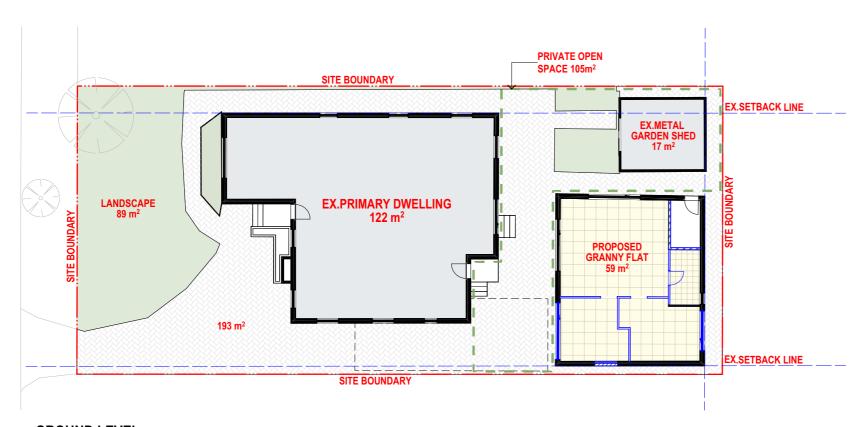

GROUND LEVEL

GFA CALCULATION

SITE AREA: 518.5 m² 259.25 m² OR 0.5:1 122 m² PERMISSIBLE GFA: EXISTING GFA: PROPOSED GFA: 59 m^2 TOTAL GFA 181 m²

PRIVATE OPEN SPACE: 105m² (COMPLY) REQUIRE: 80 m^2

SOFT LANDSCAPE

HARD STAND

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CLIENT

PROPOSED FREE-STANDING GRANNY FLAT 7 MOLLER AVENUE, BIRRONG, NSW 2143


Drawing Title

GFA Calculation GFA Calculation


Scale	Project No.		Drawn by	North
1:200 @ A3	•	24053	ĹL	
Status	Dwg No.		Rev	
For Information		DA-009		•




59 The River Road Revesby, NSW 2212 AUSTRALIA

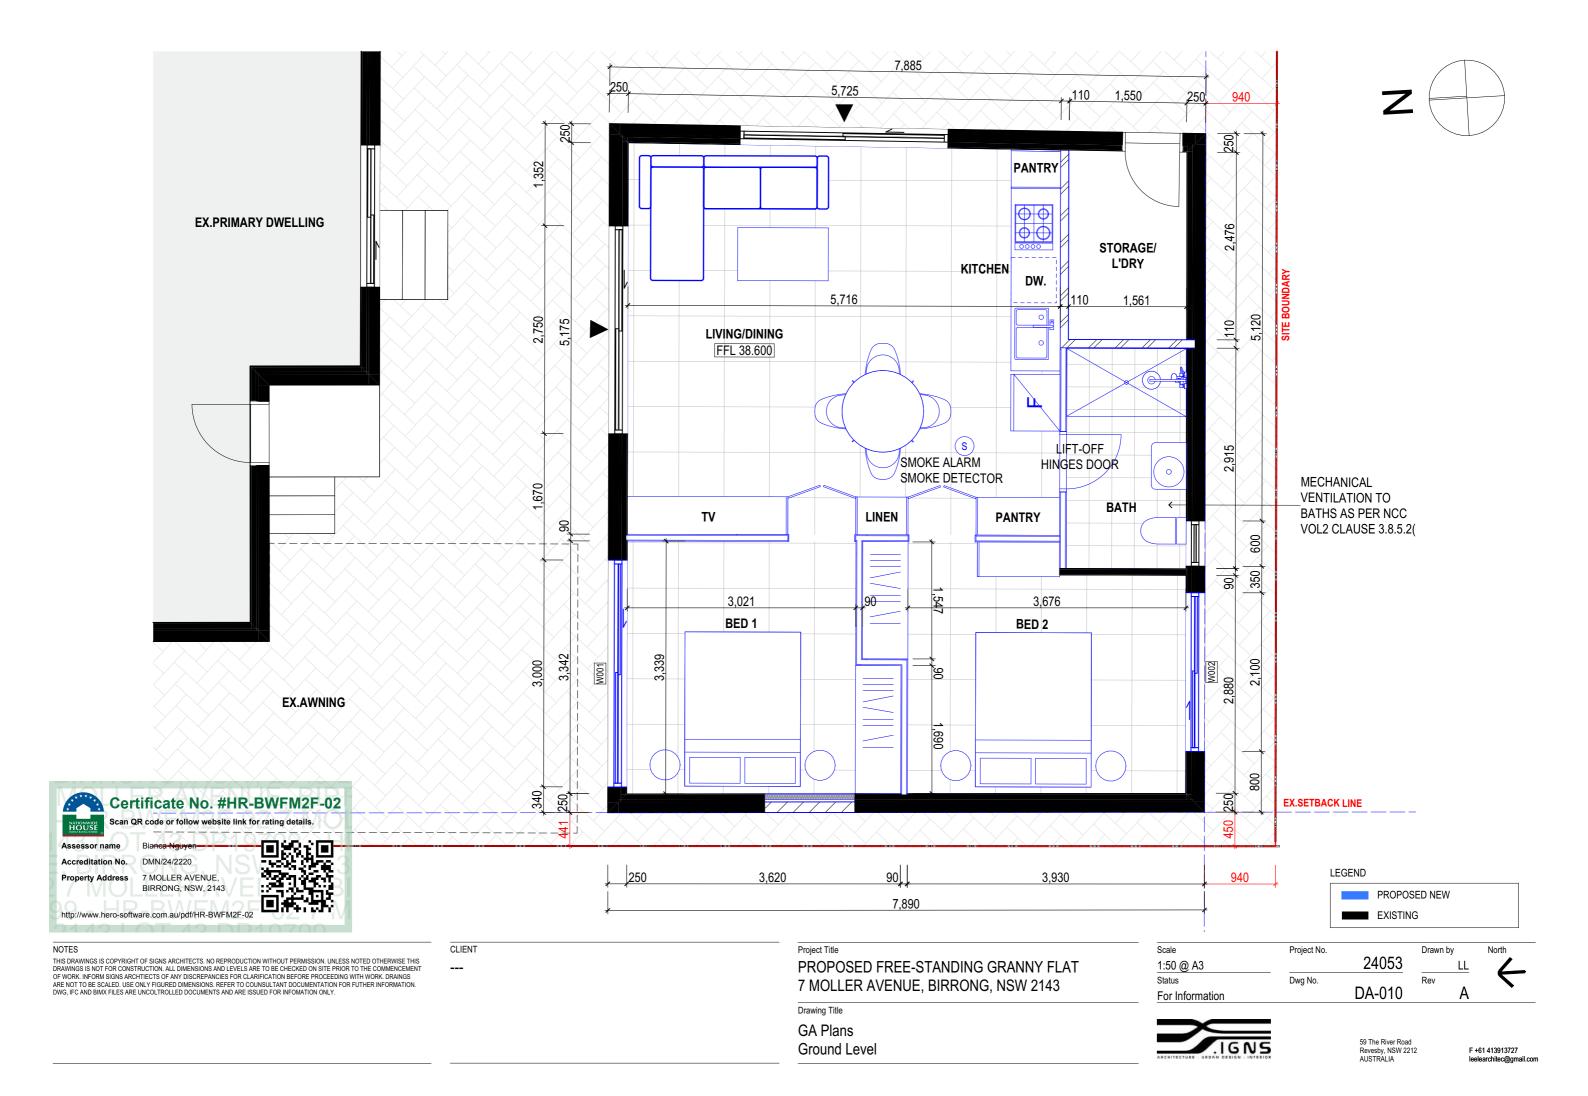




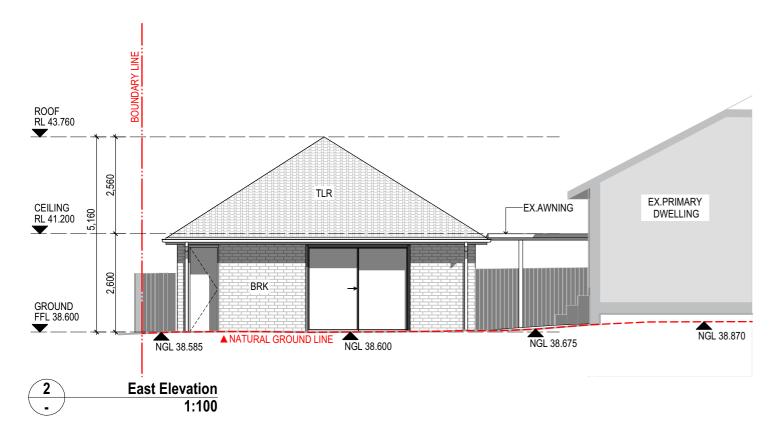

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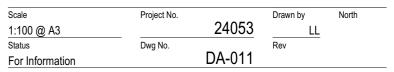


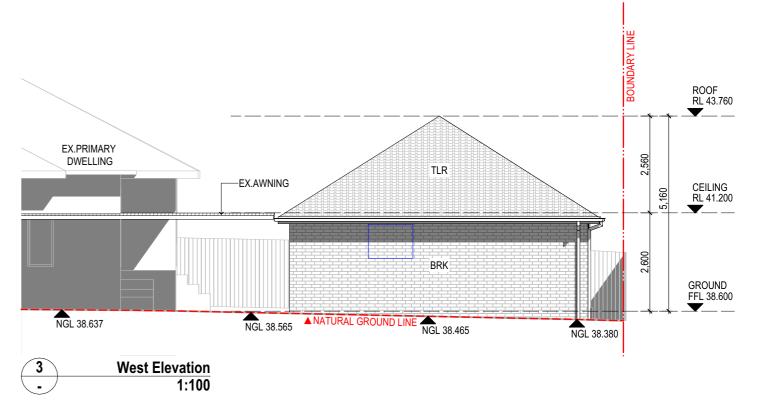

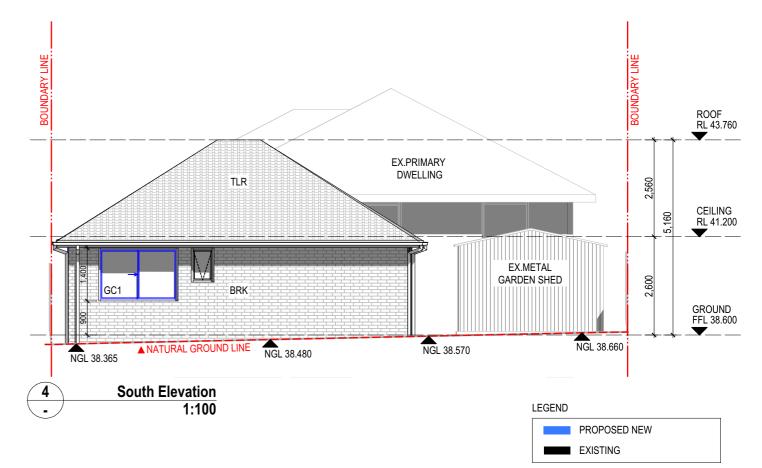PROPOSED FREE-STANDING GRANNY FLAT
7 MOLLER AVENUE, BIRRONG, NSW 2143


Drawing Title

GA Elevations Elevations





59 The River Road Revesby, NSW 2212 AUSTRALIA

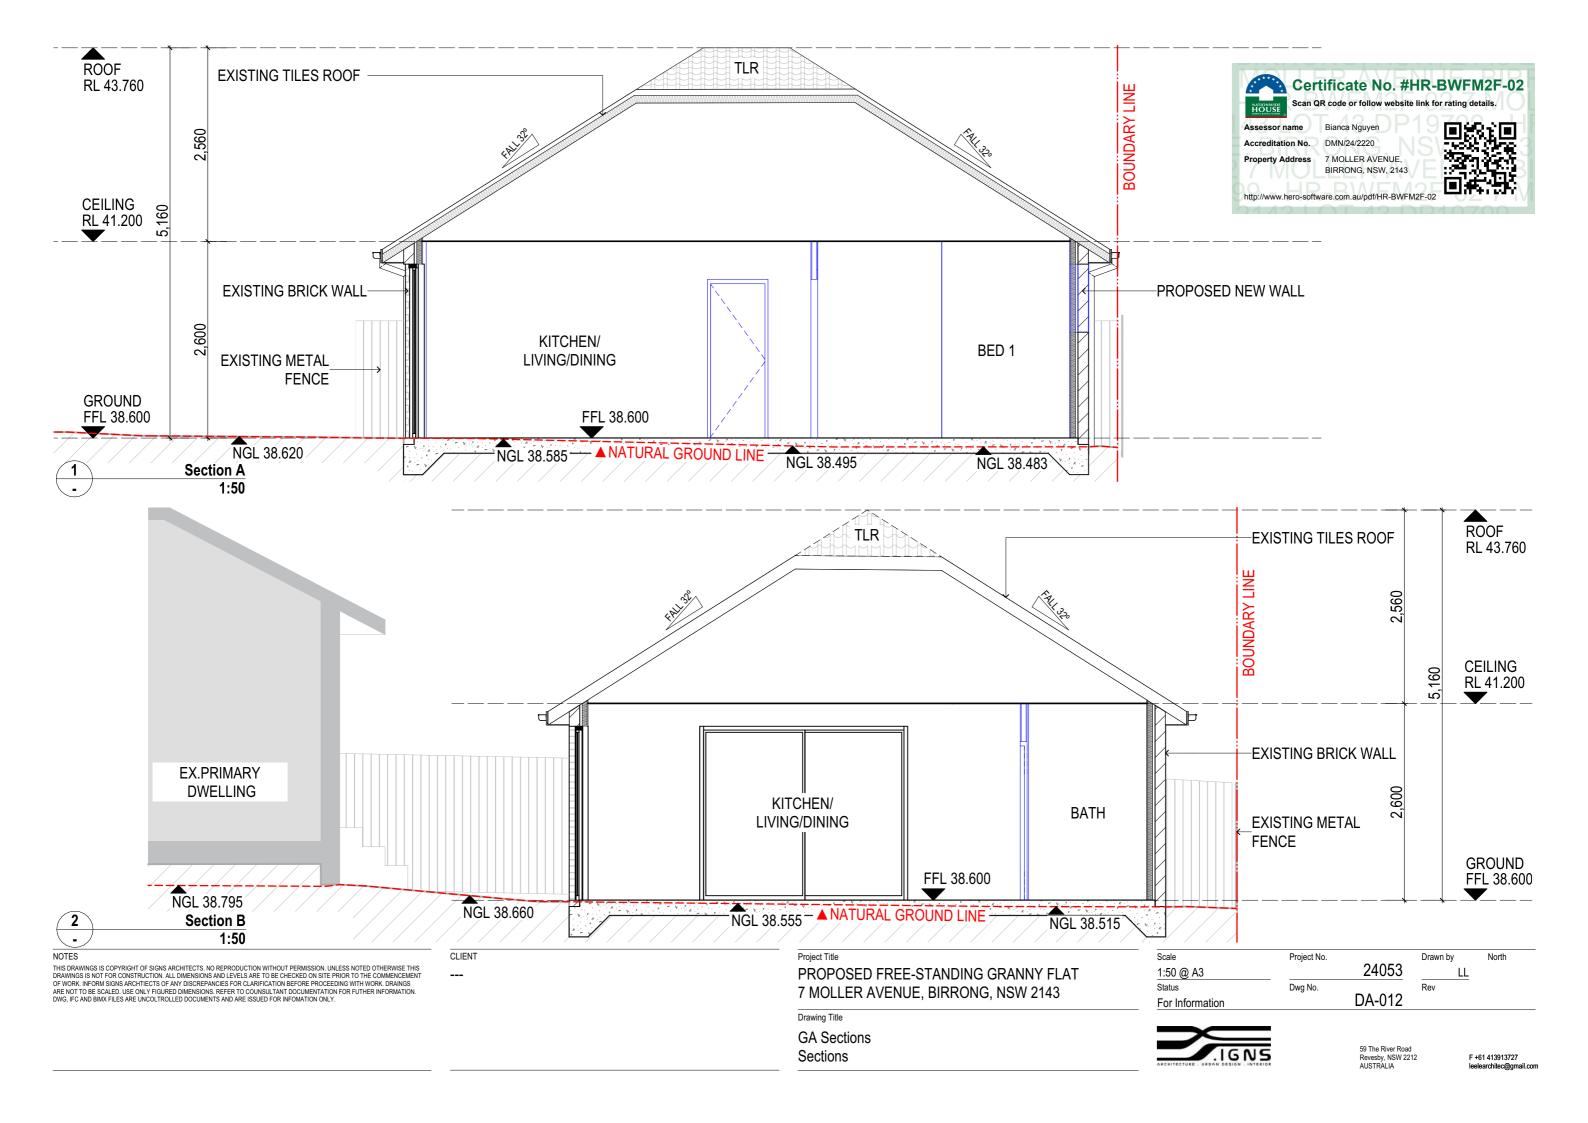

ID	W001	W002
Quantity	1	1
Nominal W x H Size	3,000×1,400	2,100×1,400
Note		
View from Reveal Side	3,000	2,100



7 MOLLER AVENUE, BIRRONG, NSW, 2143

http://www.hero-software.com.au/pdf/HR-BWFM2F-02

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PROPOSED FREE-STANDING GRANNY FLAT 7 MOLLER AVENUE, BIRRONG, NSW 2143


Drawing Title

600 Window Schedule Window Schedule


Scale	Project No.		Drawn by	North
1:1 @ A3	•	24053	LL	
Status	Dwg No.		Rev	
For Information		DA-013	Α	



59 The River Road Revesby, NSW 2212 AUSTRALIA

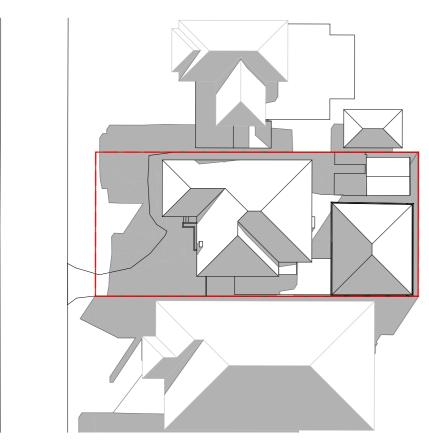

Jun 21 - 9AM - WINTER SOLSTICE

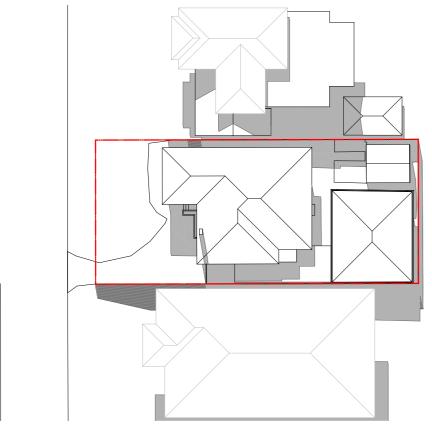

Jun 21 - 12PM - WINTER SOLSTICE

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Jun 21 - 3PM - WINTER SOLSTICE

Existing building footprint and height. No additional shadow

Project Title

PROPOSED FREE-STANDING GRANNY FLAT 7 MOLLER AVENUE, BIRRONG, NSW 2143

Drawing Title

Shadow Diagrams Shadow Diagrams





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BRK-BRICKVENEER



TLR - MONIER ROOF TILES



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Project Title

PROPOSED FREE-STANDING GRANNY FLAT 7 MOLLER AVENUE, BIRRONG, NSW 2143

Drawing Title

Material Board Material Board



Scale	Project No.		Drawn by	North
1:186.69 @ A3	•	24053	LL	
Status	Dwg No.		Rev	
For Information	-	DA-015		



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PROPOSED FREE-STANDING GRANNY FLAT 7 MOLLER AVENUE, BIRRONG, NSW 2143

Drawing Title

3D Views Perspective 01

Scale	Project No.		Drawn by	North
@ A3		24053	LL	
Status	Dwg No.		Rev	
For Information		DA-016		



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